

GROUND FLOOR PLAN



Creo Design Partnership 0405 511 163 admin@creo-design.com.au

Description A ISSUED FOR DEVELOPMENT APPLICATION GENERAL NOTES:

2. ALL DIMENSIONS SHALL BE VERIFIED

WORKS CREO DESIGN SHALL BE NOTIFIED IN WRITING OF ANY DISCREPANCIES.

ON SITE BEFORE PROCEEDING WITH

1. THIS DRAWING MUST BE READ IN CONJUNCTION WITH ALL RELEVANT CONTRACTS SPECIFICATIONS AND

3. DO NOT SCALE FROM DRAWINGS. WRITTEN DIMENSIONS GOVERN

4. ALL DIMENSIONS ARE TO CORE BRICK/STUDWORK ONLY AND DO NOT INCLUDE CLADDING AND/OR WALL FINISHES


Client MARTIN RESIDENCE Project 27B MATHESON RD, APPLECROSS WA


GROUND FLOOR GA PLAN


Project number 2109 Date 27/01/21 Drawn by Author Checked by

A200 Checker Scale

Rev A

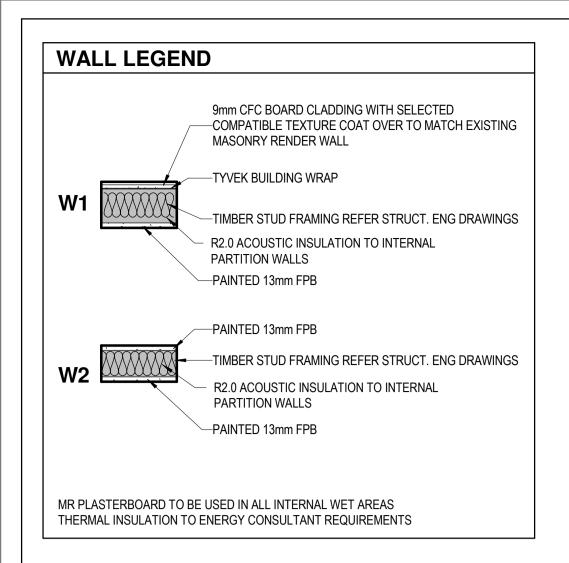

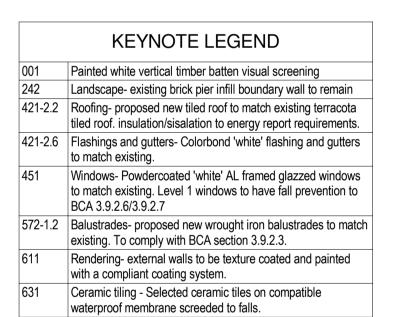

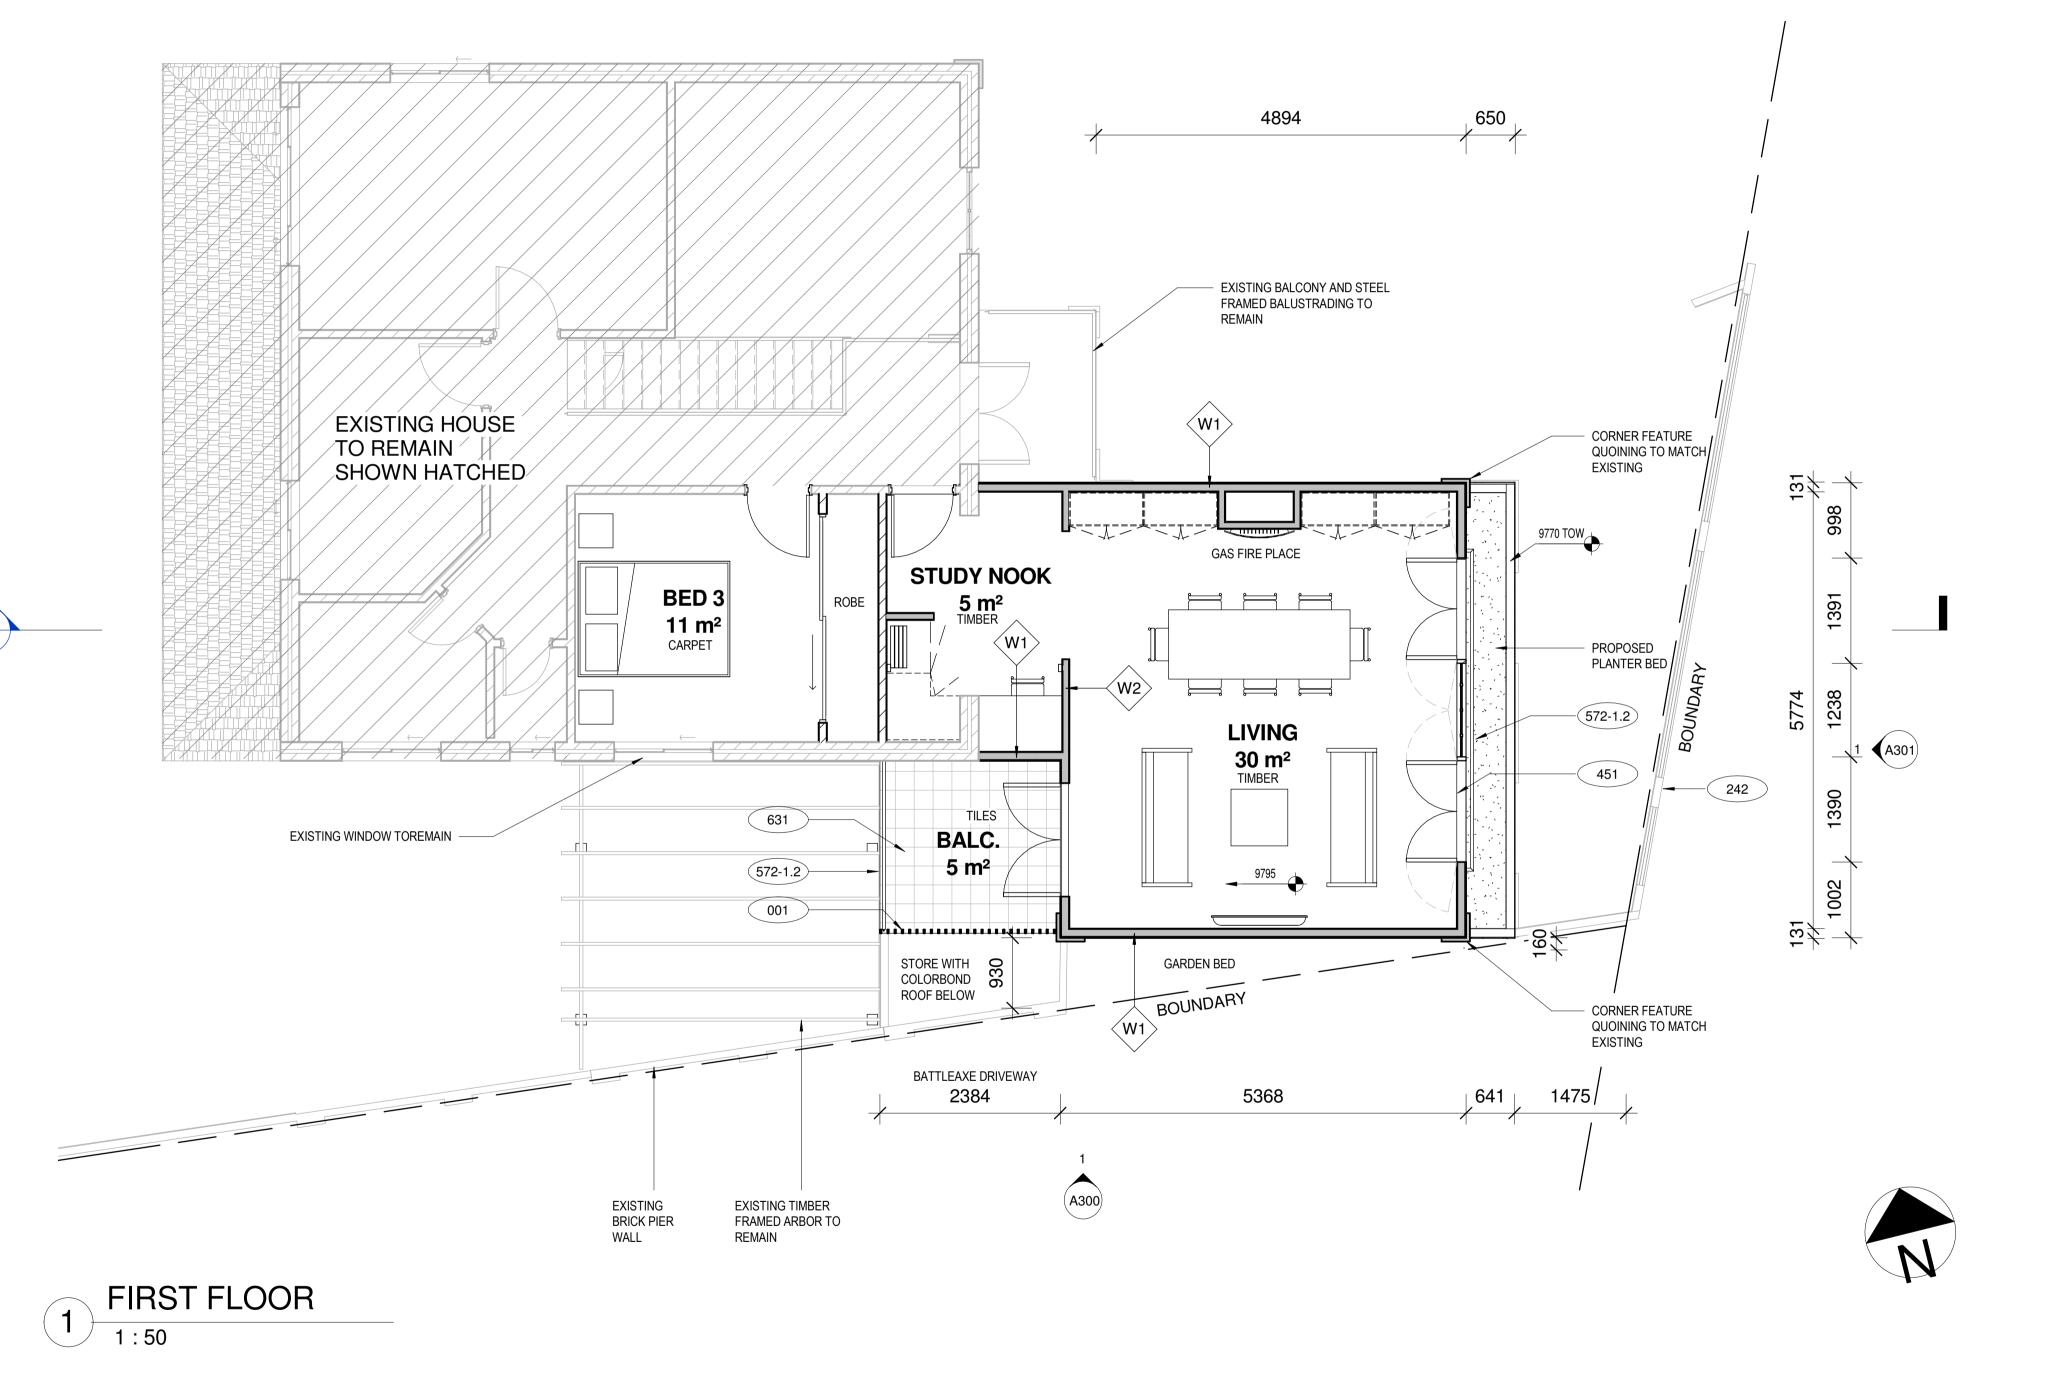



No.	Description	Date
Α	ISSUED FOR DEVELOPMENT APPLICATION	19/07/2021

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Checked by


27/01/21 A201 Author Rev **A** Checker Scale

KEYNOTE LEGEND

- Painted white vertical timber batten visual screening
- Landscape- existing brick pier infill boundary wall to remain 421-2.2 Roofing- proposed new tiled roof to match existing terracota
- tiled roof. insulation/sisalation to energy report requirements. 421-2.6 Flashings and gutters- Colorbond 'white' flashing and gutters to match existing.
- Windows- Powdercoated 'white' AL framed glazzed windows to match existing. Level 1 windows to have fall prevention to BCA 3.9.2.6/3.9.2.7
- Balustrades- proposed new wrought iron balustrades to match existing. To comply with BCA section 3.9.2.3.
- Rendering- external walls to be texture coated and painted
- Ceramic tiling Selected ceramic tiles on compatible waterproof membrane screeded to falls.

with a compliant coating system.



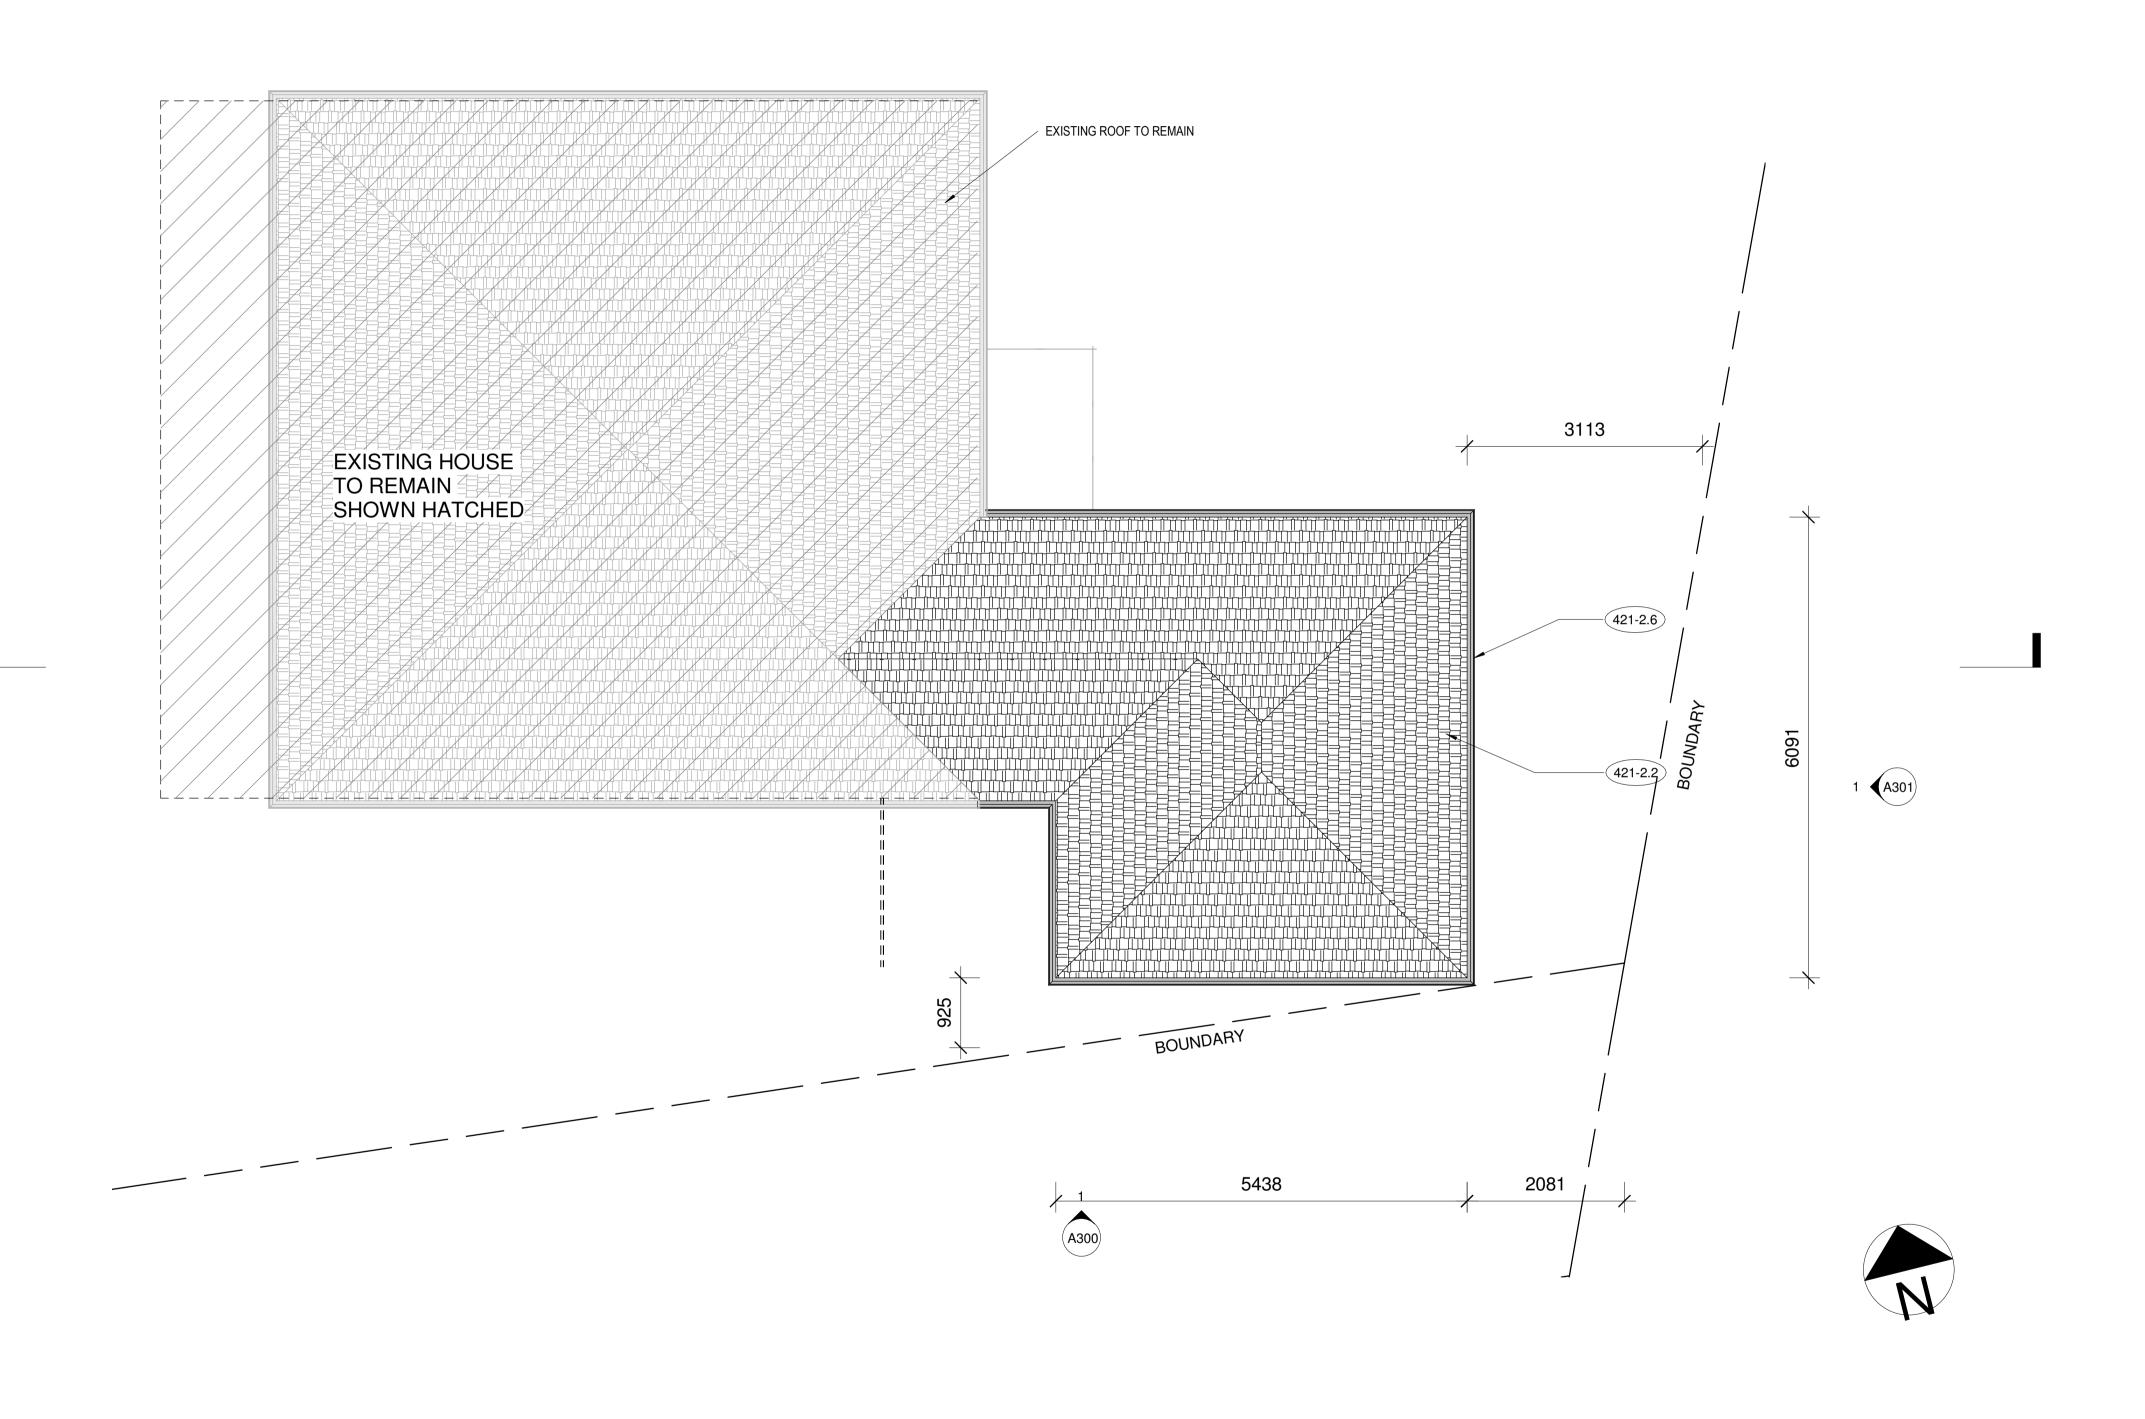

1 ROOF PLAN 1:50

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No.	Description	Date
Α	ISSUED FOR DEVELOPMENT APPLICATION	19/07/202
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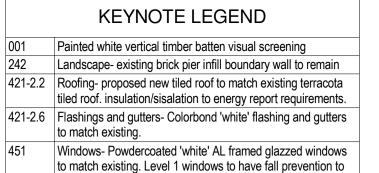
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MARTIN RESIDENCE Project 27B MATHESON RD, APPLECROSS

ROOF PLAN				
Project number	2109			
Date	27/01/21	A202		2
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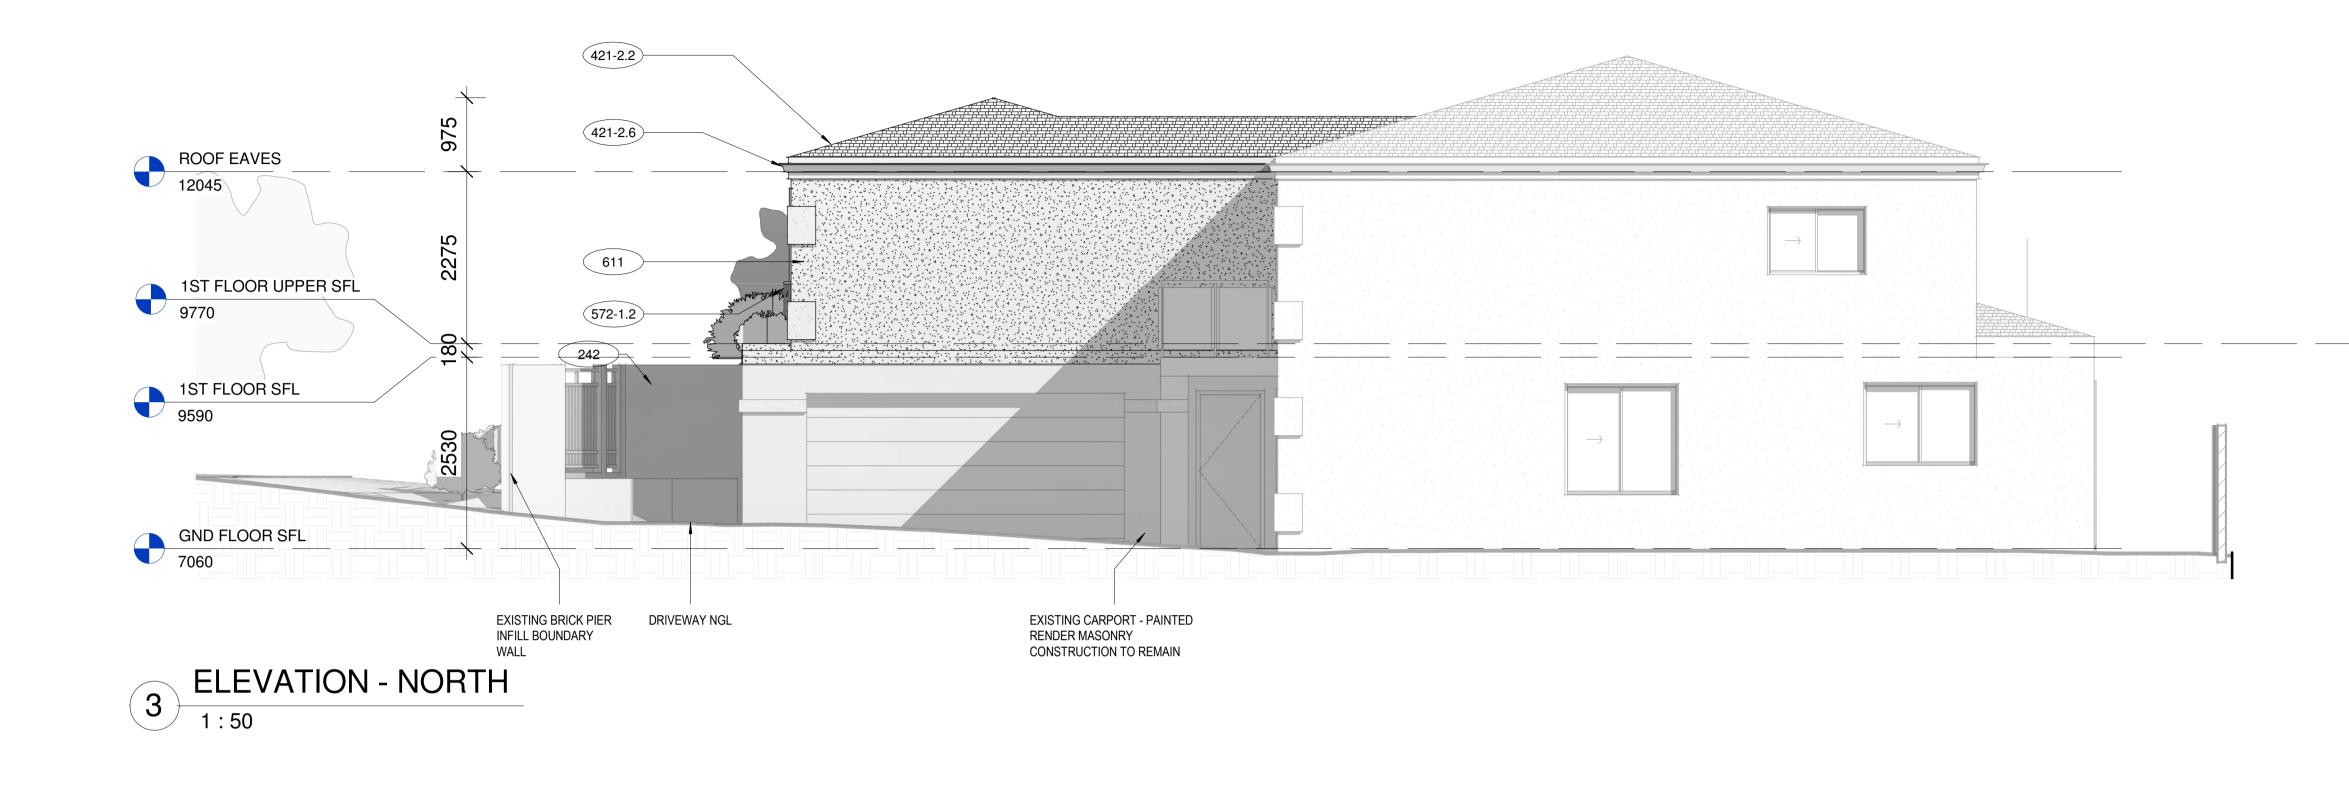



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MARTIN RESIDENCE Project 27B MATHESON RD, APPLECROSS WA

ELEVATIONS Project number 2109 27/01/21 Date A300 Drawn by Author Checker Scale 1:50 Rev A Checked by

KEYNOTE LEGEND

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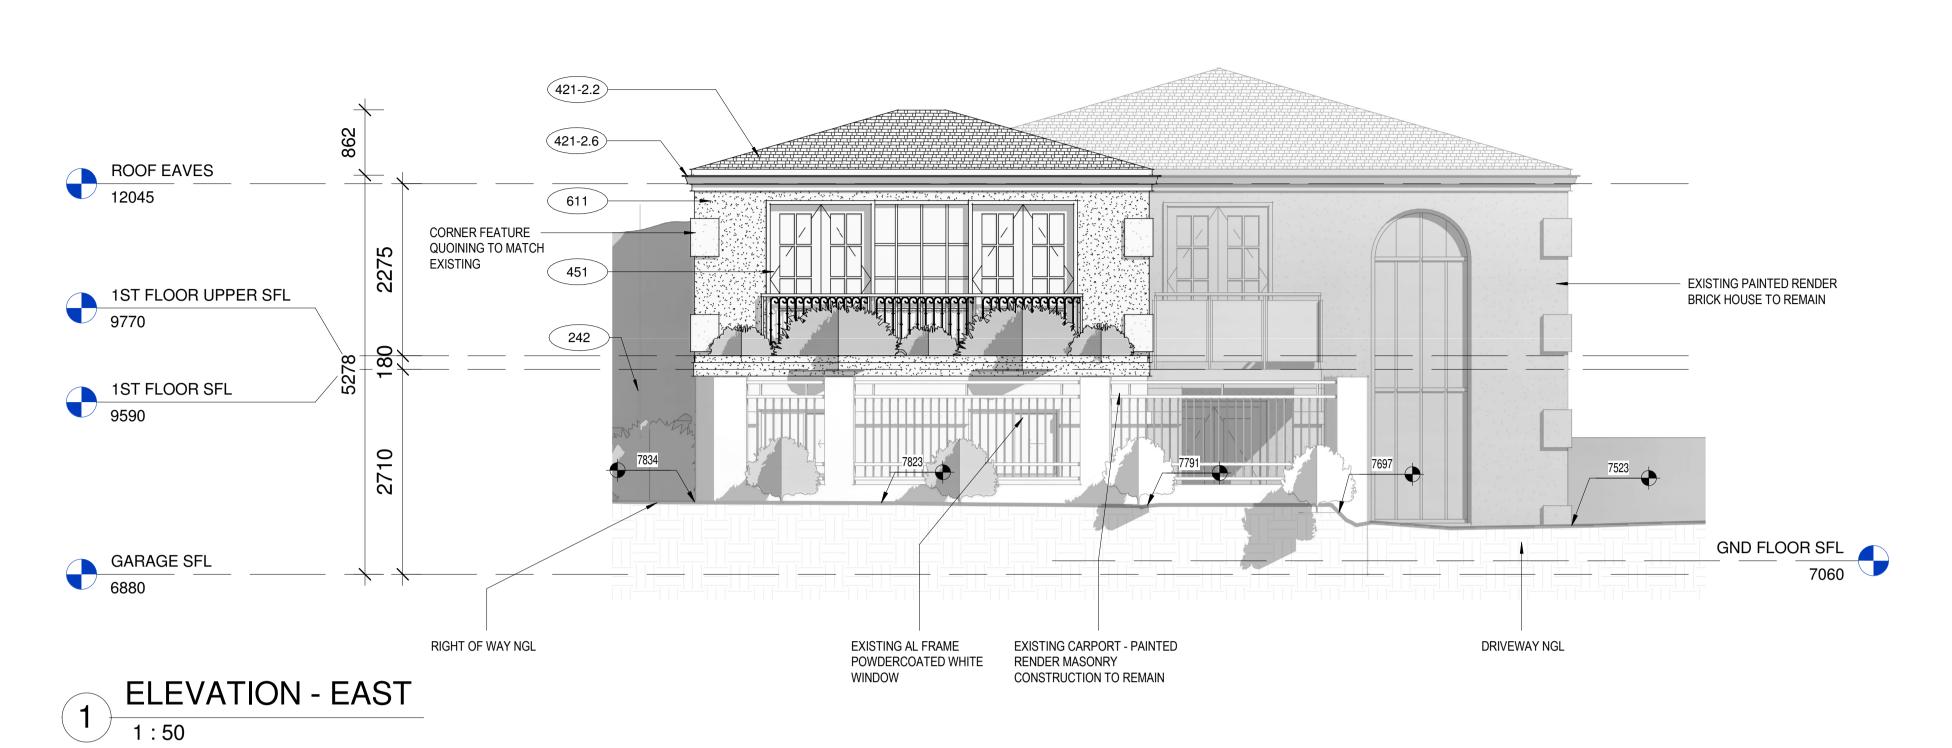
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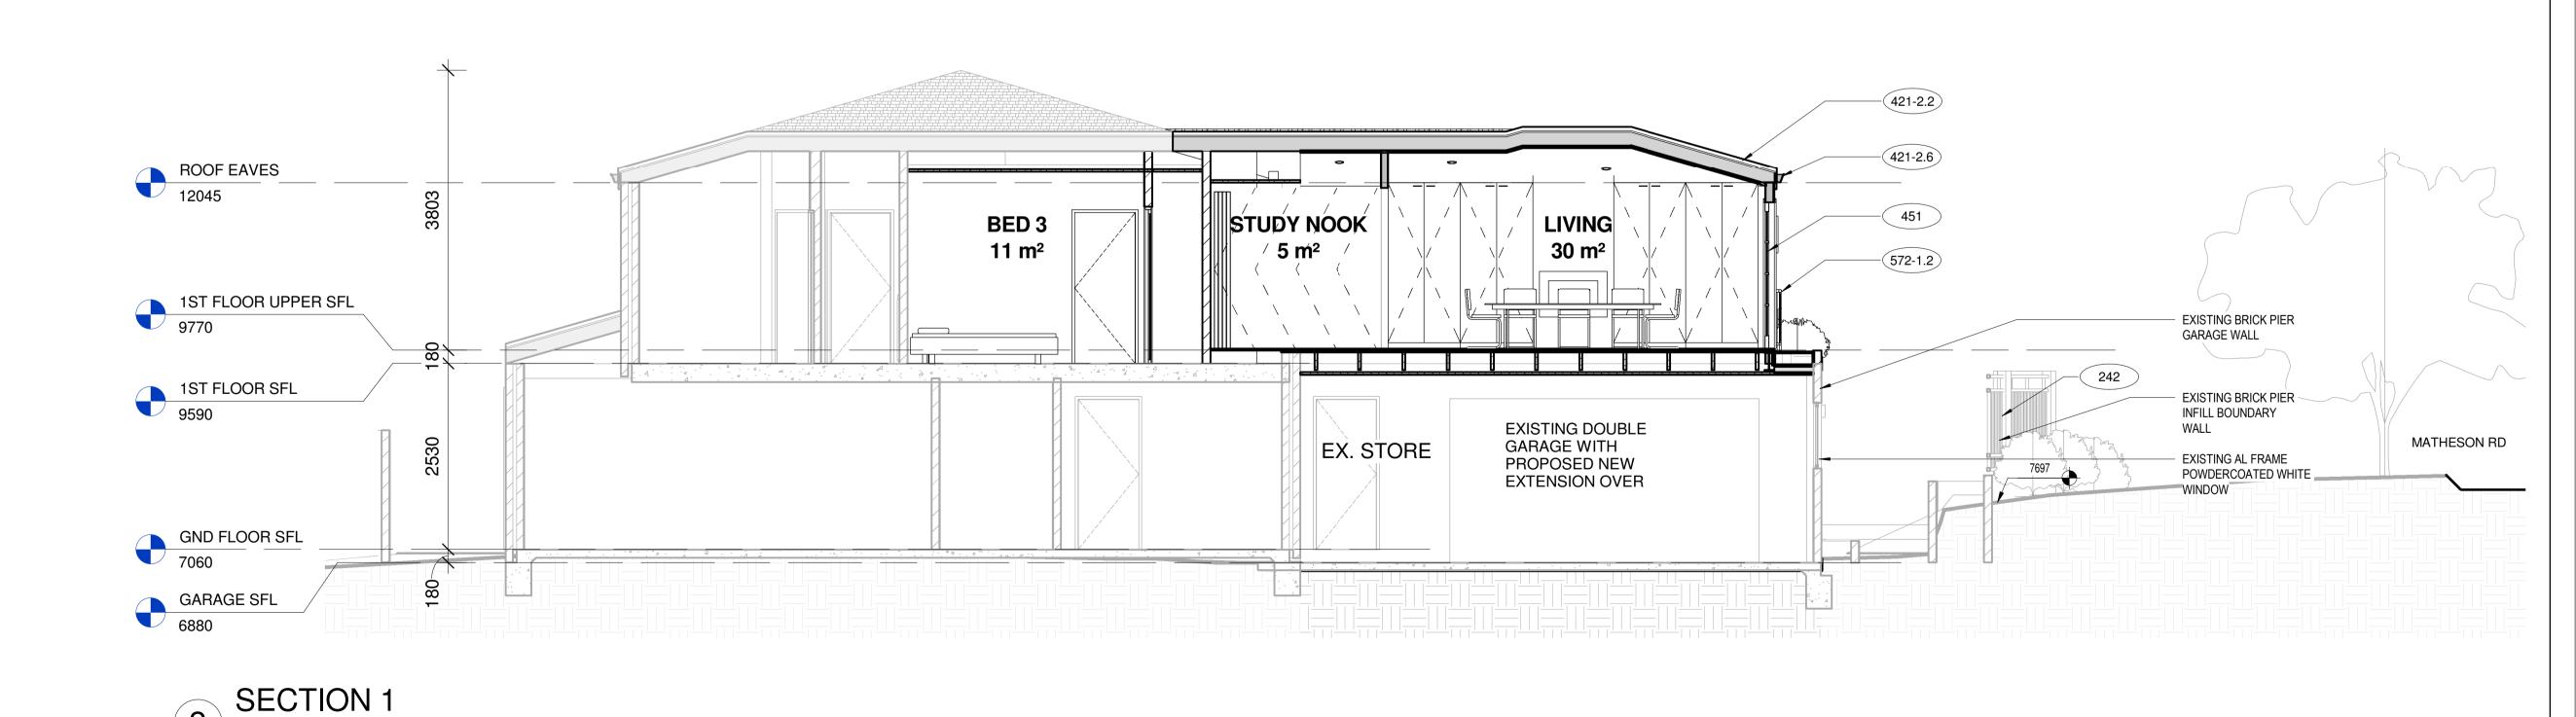
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MARTIN RESIDENCE Project 27B MATHESON RD, APPLECROSS WA

ELEVATIONS / SECTION Project number 2109 Date 27/01/21 A301 Drawn by Author 1:50 Rev **A** Checked by Checker Scale

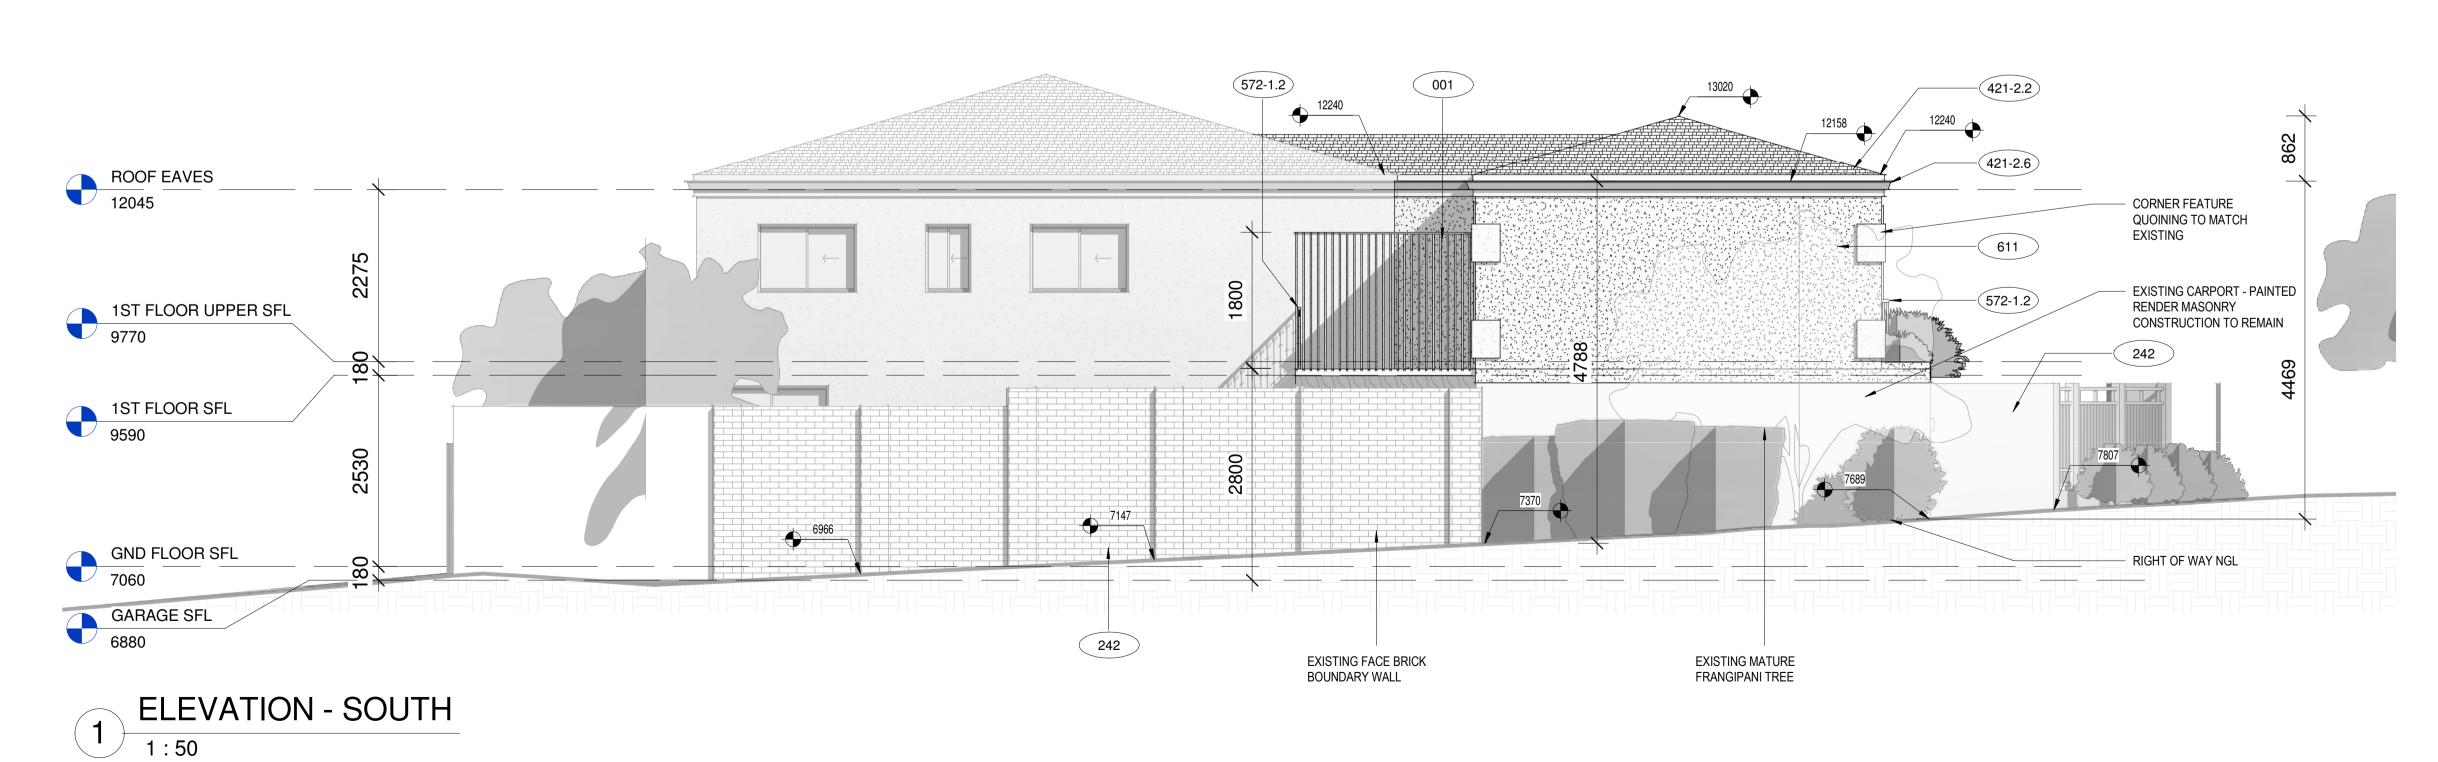

17th July 2021

Dear City of Melville, Planning

## RE: LOT 2, 27B MATHESON RD, APPLECROSS WA DEVELOPMENT APPLICATION LETTER

I am writing to confirm Creo Design's lodgment of the Development Application for a first-floor residential addition to the above address.

## Scope of Works

The project being proposed is a first-floor extension over the existing double garage with minor internal works to combine the existing upstairs bedroom and study and provide access to the proposed new living space. The existing dwelling is a double storey brick and tiled roof house with painted sand cement render external walls.

## **Planning Compliance**

We believe the proposed design meets the deemed to comply requirements of the R-codes, however we are seeking a concession regarding street setback deemed-to-comply requirements. The relevant section is outlined below along with written explanation of the design principles achieved.

## 5.1.2 Street Setback

- Required set back = 6m (can be reduced by up to half with compensating area)
- Provided setback = 3.1m to 2.05m
- Encroaching area = 22.7m<sup>2</sup> (into 6m setback area)
- Compensating area = 35.7m²

We are seeking a reduction to the stipulated set back from the street frontage to fit over the existing double garage. To address and mitigate the encroachment into the street setback and the building mass visible from the street, the following design elements have been adopted.

- The upper level is set back facing the street front from the existing ground floor garage wall face 650mm.
- The proposed new building width accounts for approx. 35% of the total boundary width. With the main house setback 9-10m from the boundary providing
- Building height has been kept to a minimum (4.5m above NGL at the southern corner). The lower existing ground level also assists in reducing the visible portion of the building from the south end of the street.
- The quoin features on the corners of the existing building have been replicated on the proposed new addition to break up the building mass and any blank wall faces. Full height French doors and Juliet balcony have been added to also reduce the amount of wall mass visible with a planter box in front to provide soft landscaping and screening.

We believe the proposed deviation from the deemed-to-comply solutions maintain the design principles of the R-codes and town planning scheme while having no adverse impact on adjacent properties and streetscape. I trust the above explanations adequately detail the concessions we are targeting. Should you have any queries, please don't hesitate to get in contact.